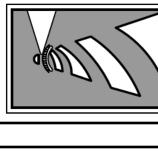


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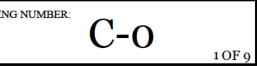
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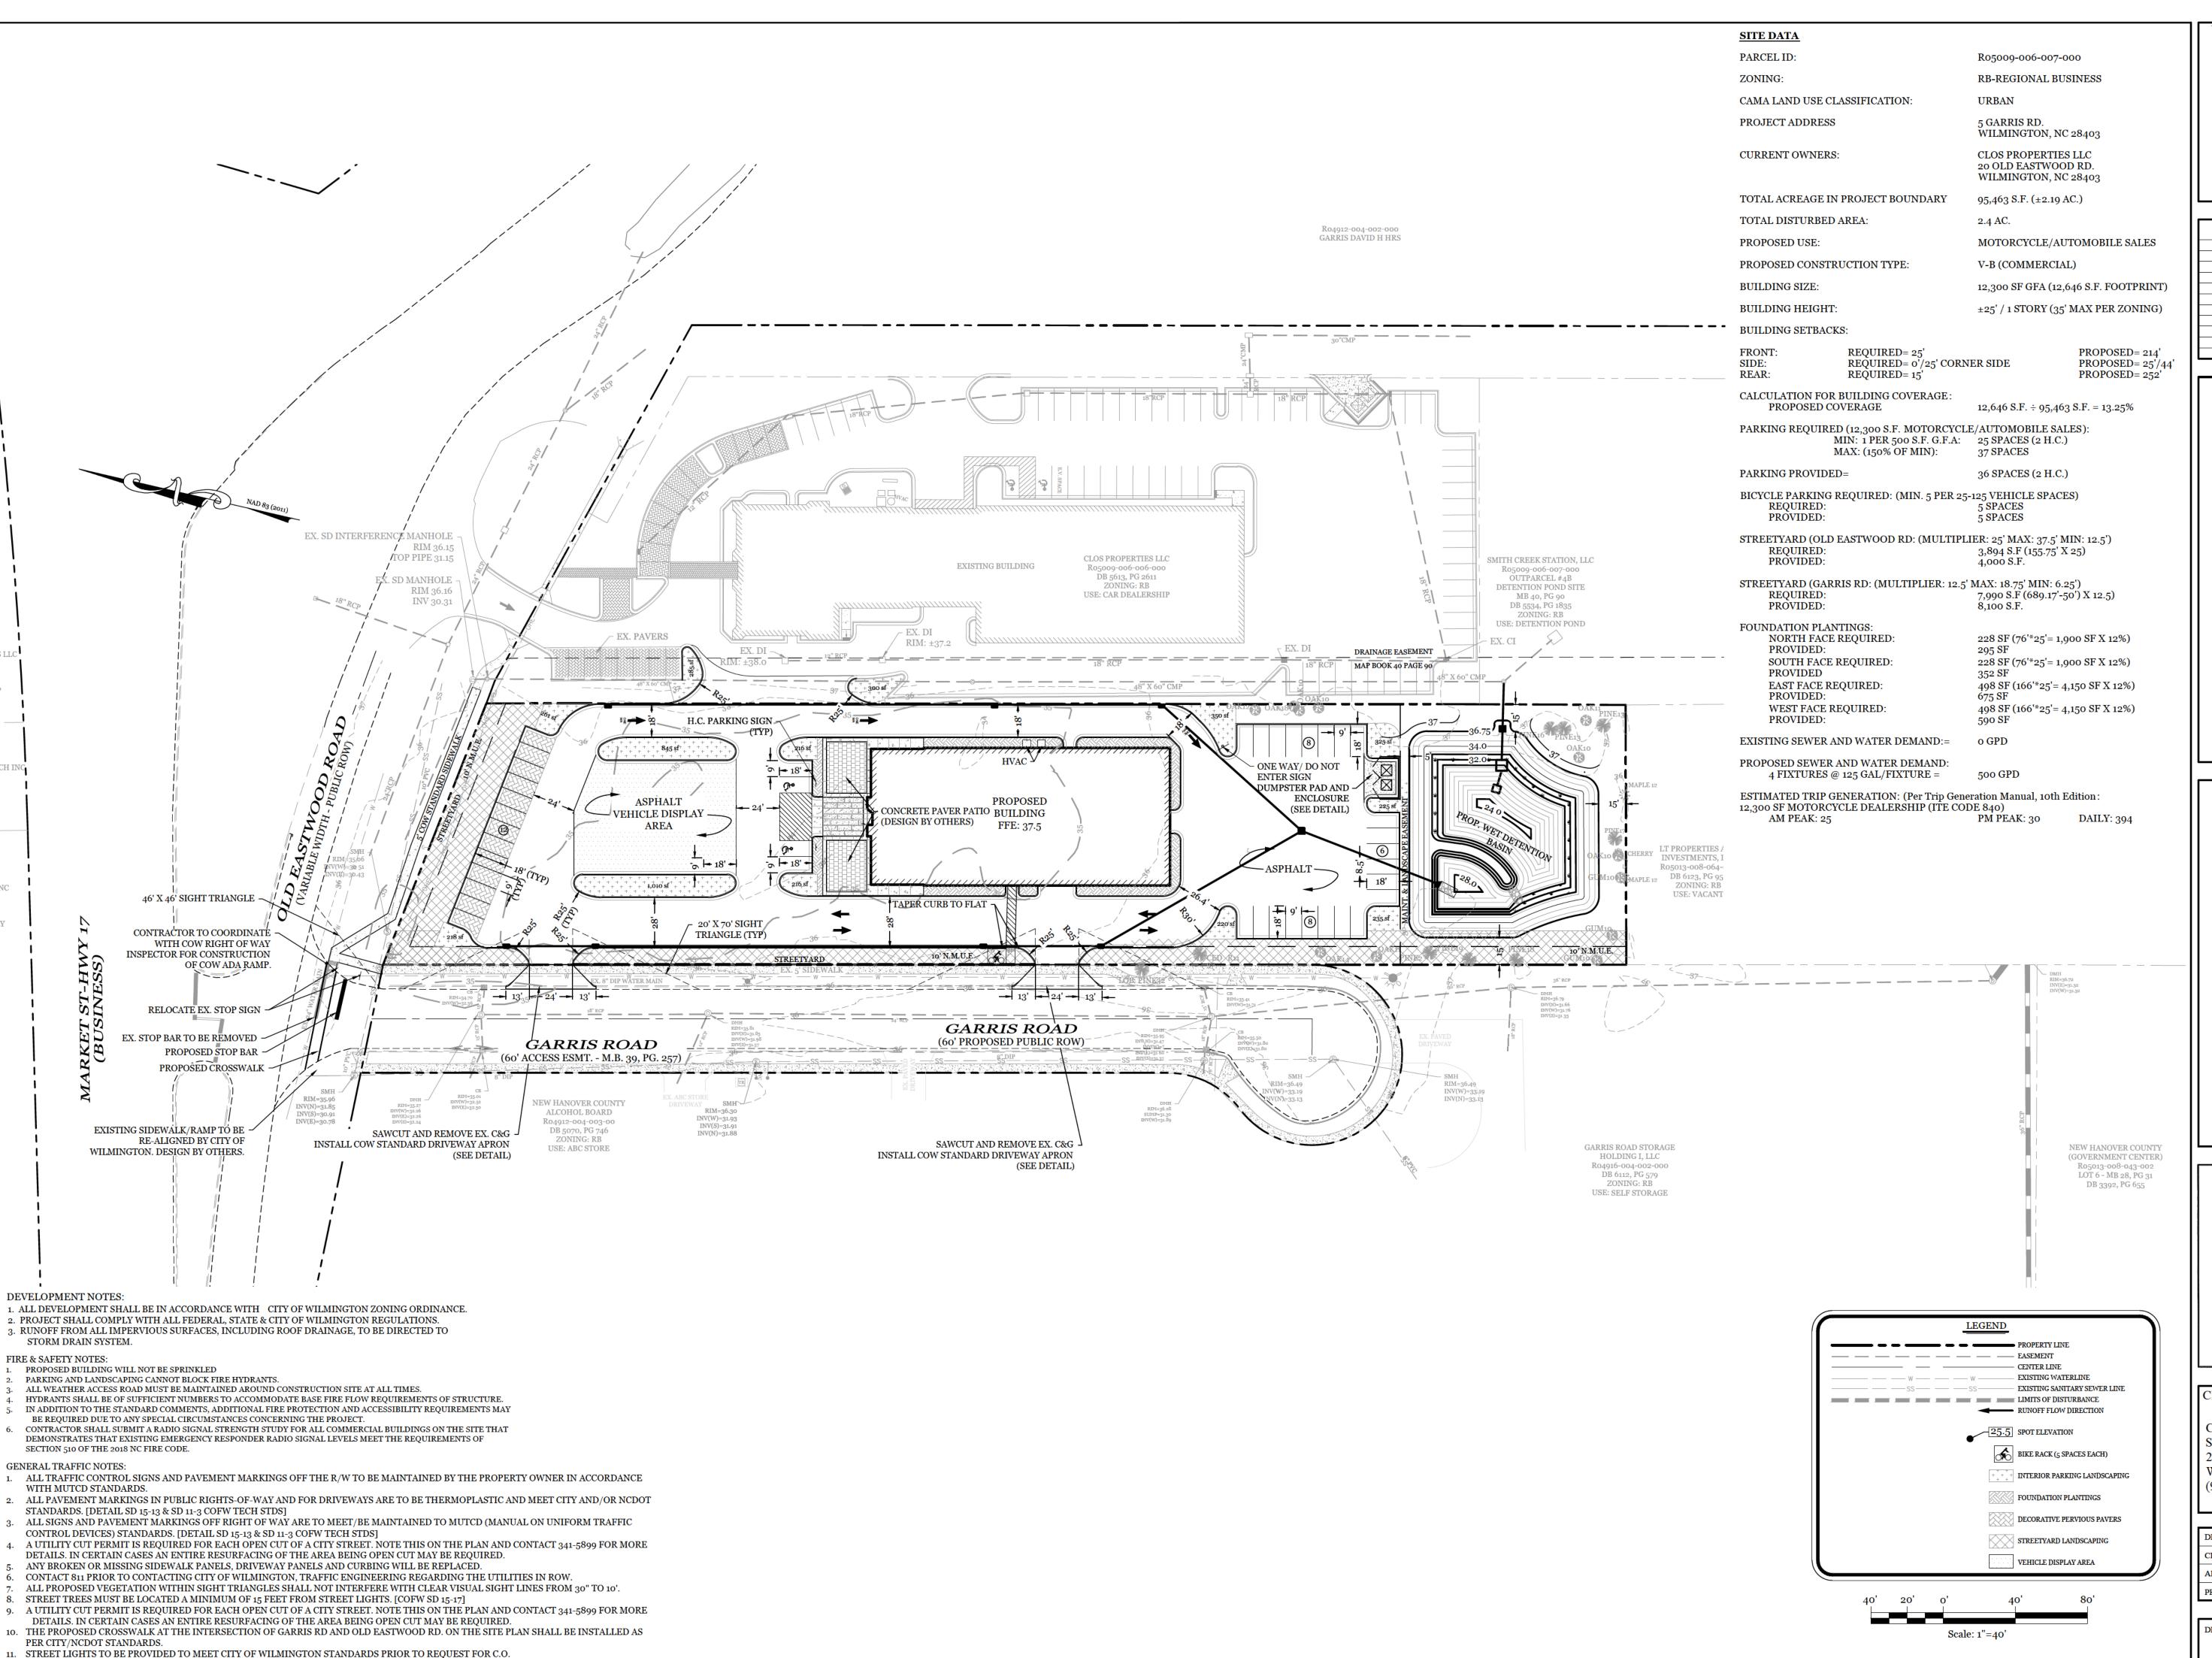


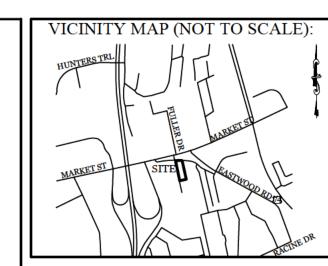
CLIENT INFORMATION:

CLOS PROPERTIES, LLC SHANE HEFFERNAN 255 OLD EASTWOOD ROAD WILMINGTON, NC 28403 (910) 202-4662

DRAWN:	JAE	SHEET SIZE:	24 X 36
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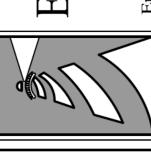




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DASTAL
ING, PLLC
Carolina 28403
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GROUP 2

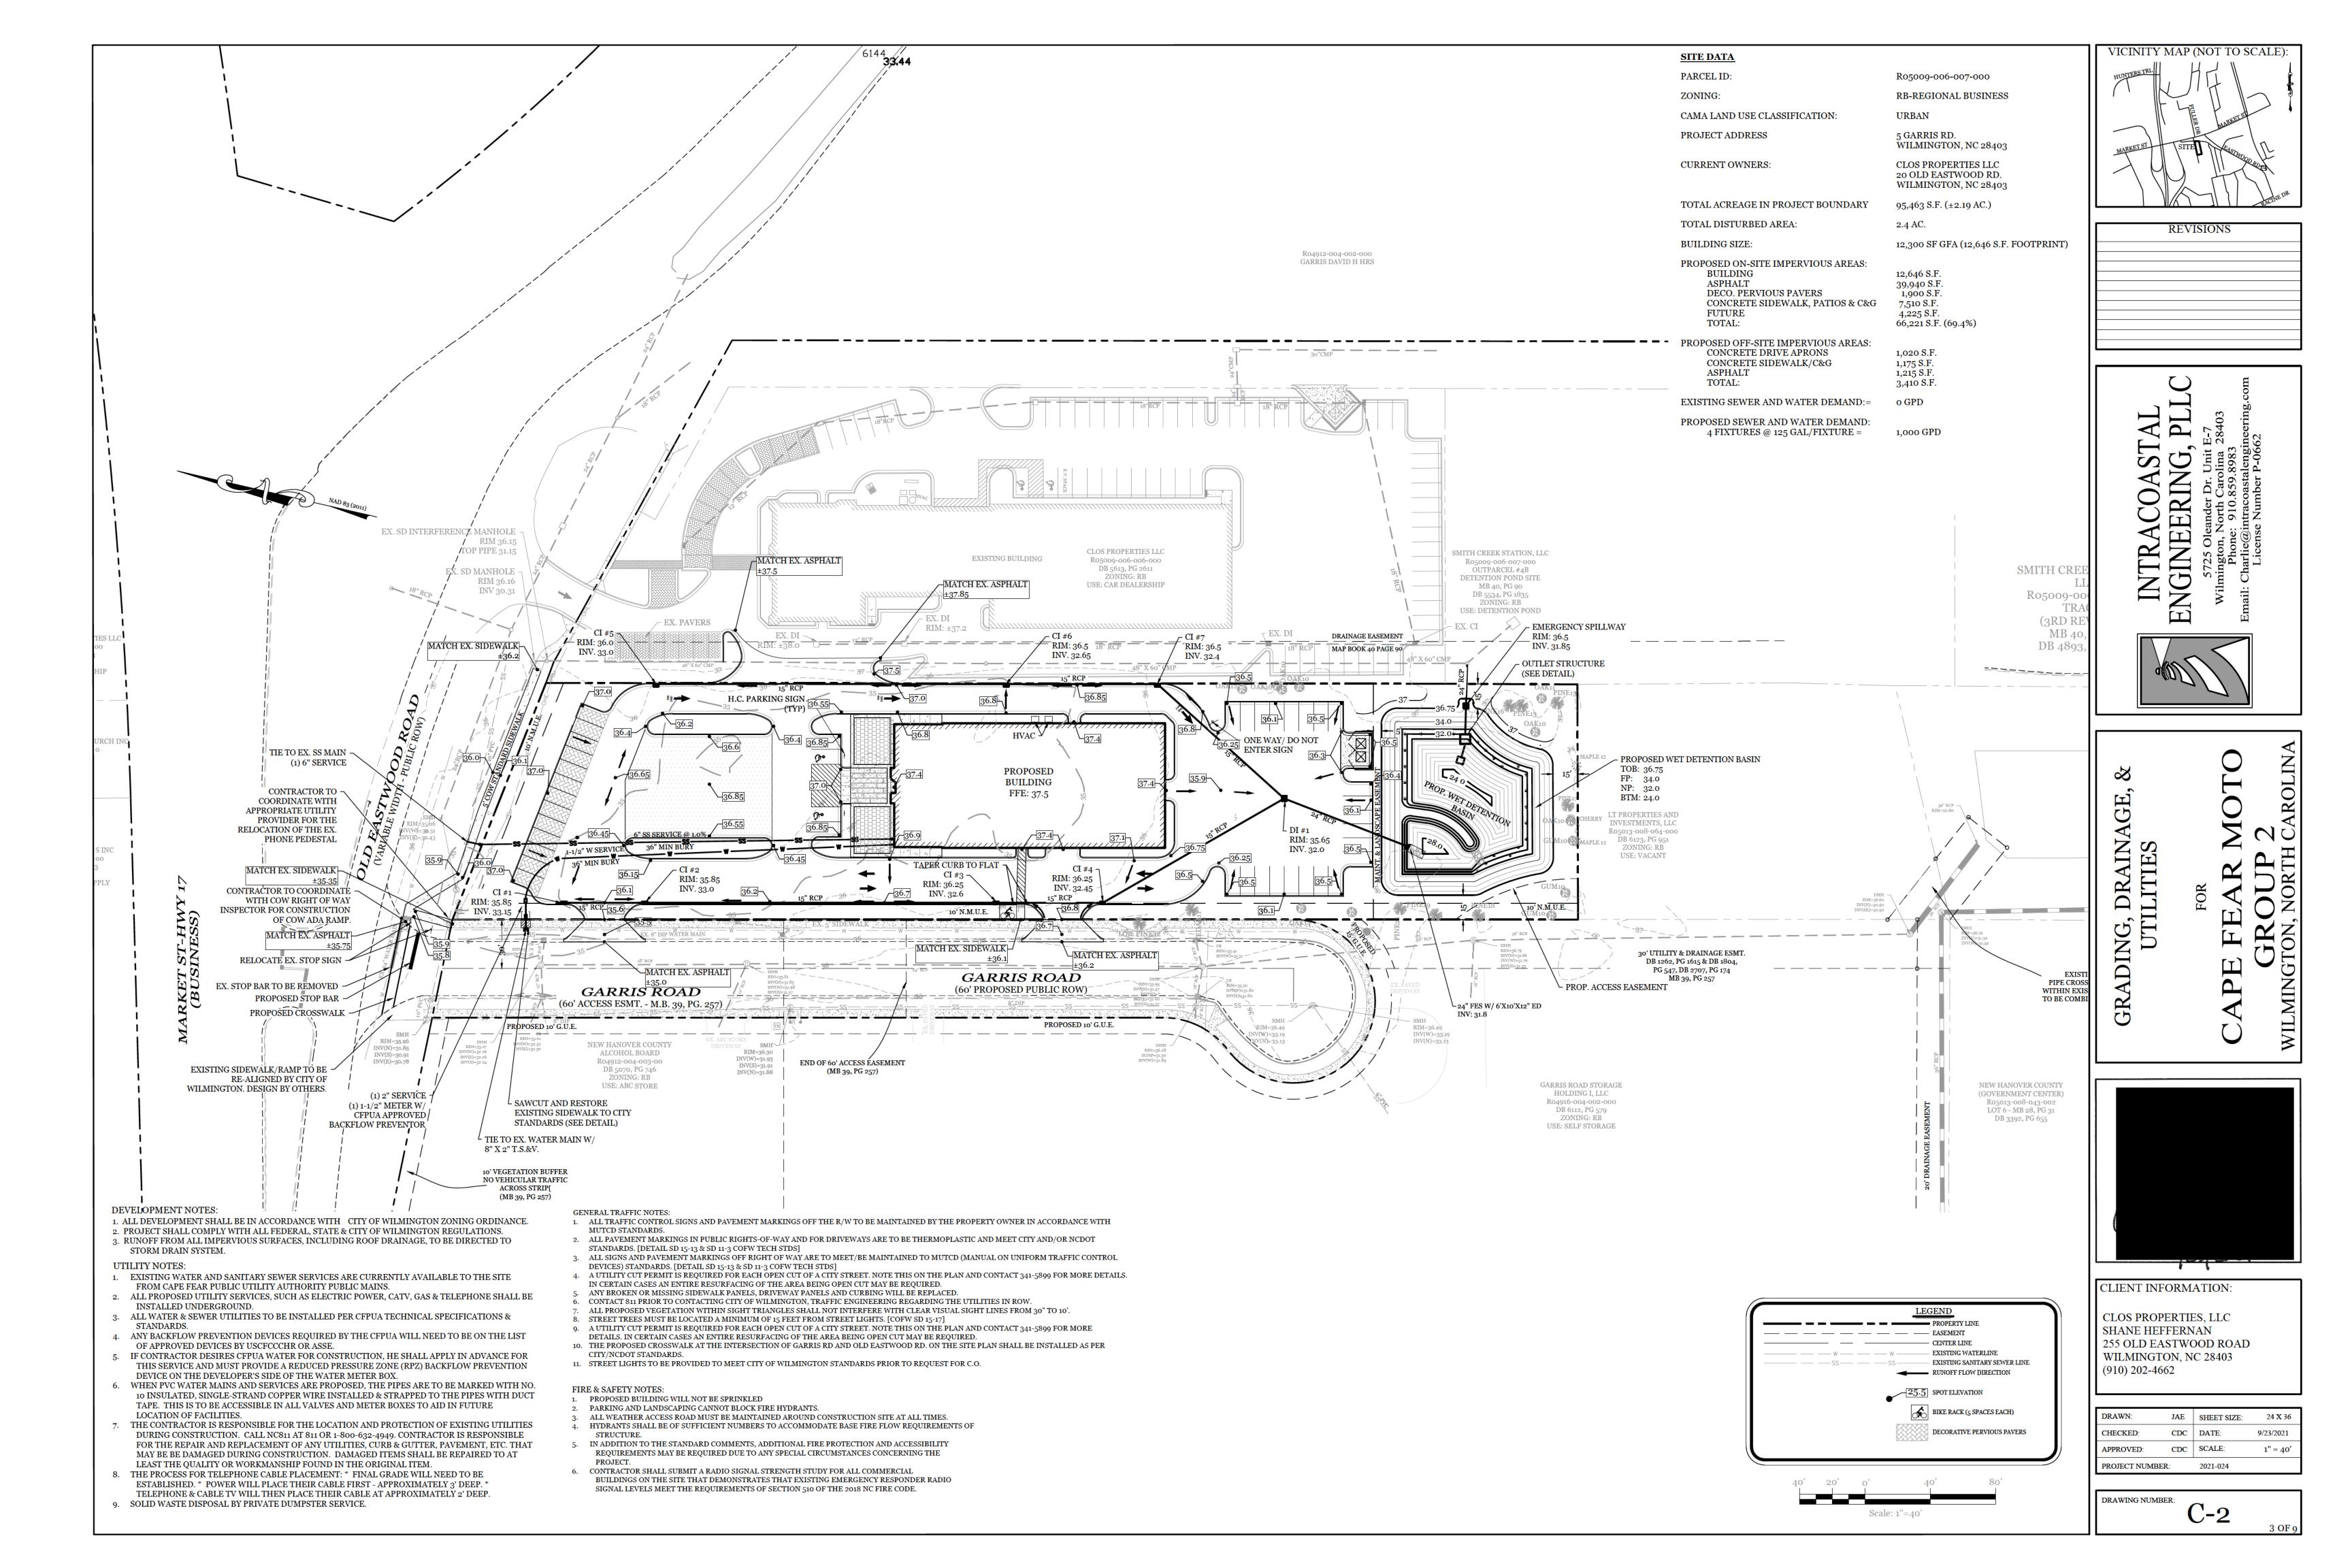
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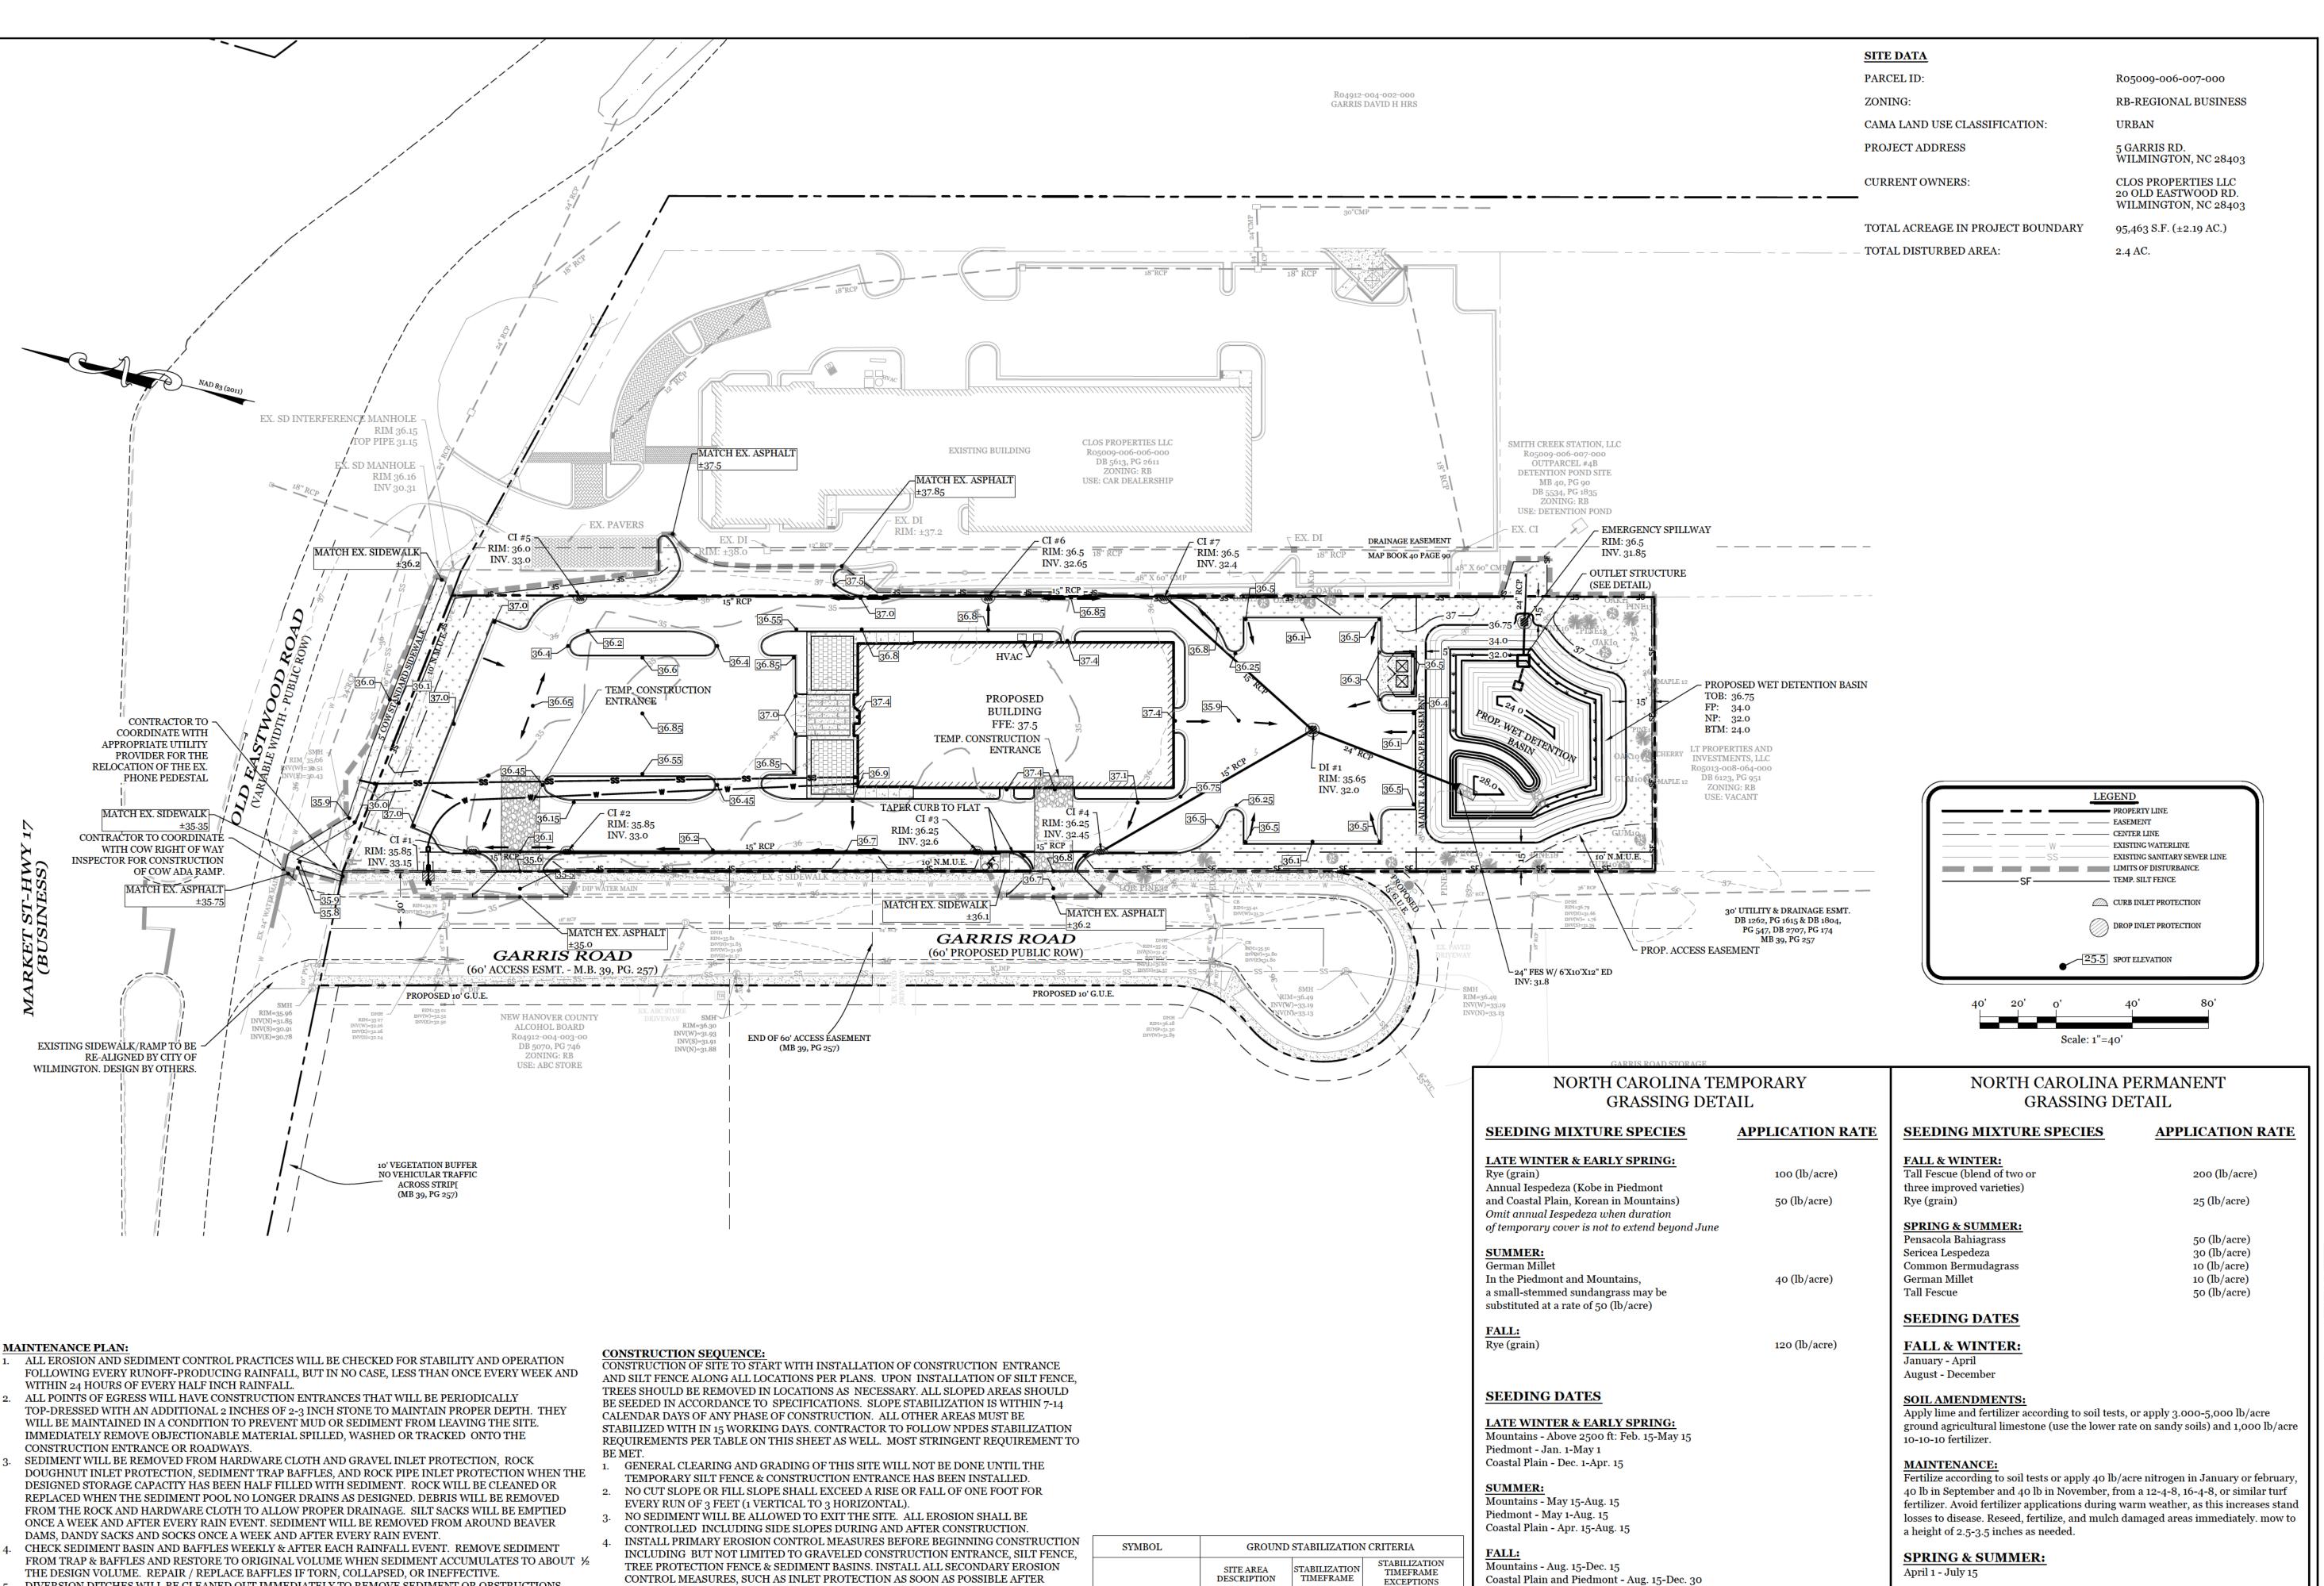
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ALL EROSION AND SEDIMENT CONTROL PRACTICES WILL BE CHECKED FOR STABILITY AND OPERATION

ALL POINTS OF EGRESS WILL HAVE CONSTRUCTION ENTRANCES THAT WILL BE PERIODICALLY WILL BE MAINTAINED IN A CONDITION TO PREVENT MUD OR SEDIMENT FROM LEAVING THE SITE. IMMEDIATELY REMOVE OBJECTIONABLE MATERIAL SPILLED, WASHED OR TRACKED ONTO THE

- DESIGNED STORAGE CAPACITY HAS BEEN HALF FILLED WITH SEDIMENT. ROCK WILL BE CLEANED OR REPLACED WHEN THE SEDIMENT POOL NO LONGER DRAINS AS DESIGNED. DEBRIS WILL BE REMOVED FROM THE ROCK AND HARDWARE CLOTH TO ALLOW PROPER DRAINAGE. SILT SACKS WILL BE EMPTIED ONCE A WEEK AND AFTER EVERY RAIN EVENT. SEDIMENT WILL BE REMOVED FROM AROUND BEAVER DAMS, DANDY SACKS AND SOCKS ONCE A WEEK AND AFTER EVERY RAIN EVENT.
- CHECK SEDIMENT BASIN AND BAFFLES WEEKLY & AFTER EACH RAINFALL EVENT. REMOVE SEDIMENT
- DIVERSION DITCHES WILL BE CLEANED OUT IMMEDIATELY TO REMOVE SEDIMENT OR OBSTRUCTIONS FROM THE FLOW AREA. THE DIVERSION RIDGES WILL ALSO BE REPAIRED. SWALES MUST BE TEMPORARILY STABILIZED WITHIN 21 CALENDAR DAYS OF CEASE OF ANY PHASE OF ACTIVITY ASSOCIATED
- WITH A SWALE. SEDIMENT WILL BE REMOVED FROM BEHIND THE SEDIMENT FENCE WHEN IT BECOMES HALF FILLED. THE SEDIMENT FENCE WILL BE REPAIRED AS NECESSARY TO MAINTAIN A BARRIER. STAKES MUST BE STEEL. STAKE SPACING WILL BE 6 FEET MAX. WITH THE USE OF EXTRA STRENGTH FABRIC, WITHOUT WIRE BACKING. STAKE SPACING WILL BE 8 FEET MAX WHEN STANDARD STRENGTH FABRIC AND WIRE BACKING ARE USED. IF ROCK FILTERS ARE DESIGNED AT LOW POINTS IN THE IN THE SEDIMENT FENCE THE ROCK WILL BE REPAIRED OR REPLACED IF IT BECOMES HALF FULL OF SEDIMENT, NO LONGER DRAINS AS DESIGNED OR IS DAMAGED.
- FAIRCLOTH SKIMMER TO BE ROUTINELY CHECKED FOR SEDIMENT ACCUMULATION, TRASH, AND DEBRIS CLOGGING THE WATER ENTRY ORIFICES. PULL SKIMMER TO SIDE OF BASIN AND HAND REMOVE SEDIMENT AND DEBRIS TO RESTORE FLOW TO ORIGINAL STATE.
- CONTROL MEASURES, SUCH AS INLET PROTECTION AS SOON AS POSSIBLE AFTER
- ALL EROSION CONTROL MEASURES TO BE INSPECTED AFTER EACH RAIN. SILT FENCI AND INLET PROTECTION TO BE CLEANED WHEN HALF FULL A 4" LAYER OF TOPSOIL SHALL BE APPLIED TO ALL NEW AREAS TO BE GRASSED.
- MAINTAIN ALL EROSION CONTROL MEASURES UNTIL PROJECT IS COMPLETE. MORE STRINGENT MEASURES MAY BE REQUIRED TO HALT EROSION IF THOSE ON TI PLAN PROVE TO BE LESS EFFECTIVE.
- REMOVE ALL TEMPORARY EROSION CONTROL MEASURES UPON COMPLETION OF CONSTRUCTION. ALL PERMANENT MEASURES SHALL BE WELL ESTABLISHED PRIOR PROJECT COMPLETION.

SYMBOL	GROUND STABILIZATION CRITERIA			
	SITE AREA DESCRIPTION	STABILIZATION TIMEFRAME	STABILIZATION TIMEFRAME EXCEPTIONS	
	* Perimeter dikes, swales, ditches and slopes	7 Days	None	
	* High Quality Water (HQW) Zones	7 Days	None	
	* Slopes Steeper than 3:1	7 Days	If slopes are 10' or less in length and are not steeper than 2:1, 14 days are allowed	
\( \psi \ \psi \psi	* Slopes 3:1 or flatter	14 Days	7-days for slopes greater than 50 ft. in length	
\(\psi\) \(\	* All other areas with slopes flatter than 4:1	14 Days	None (except for perimeters & HQW Zones)	

**SOIL AMENDMENTS:** 

anchoring tool.

limestone and 750 lb/acre 10-10-10 fertilizer.

following erosion or other damage.

Follow recommendations of soil tests or apply 2,000 lb/acre ground agricultural

apply 4,000 lb/acre straw. anchor straw by tacking with asphalt, netting, or a

mulch anchoring tool. A disk with blades set nearly straight can be used as a mulci

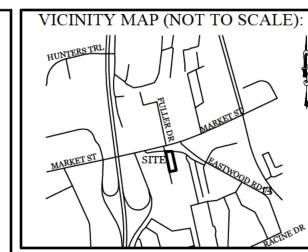
Refertilize if growth is not fully adequate. reseed, refertilize and mulch immediatel

Apply lime and fertilizer according to soil tests, or apply 3,000 lb/acre ground agriculture limestone and 500 lb/acre 10-10-10 fertilizer.

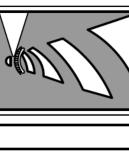
## **MAINTENANCE:**

 $\overline{\text{Refertilize}}$  the following april with 50 lb/acre nitrogen. Repeat as growth requires. may be moved only once a year. Where a neat appearance is desired, omit sericea and mow as often as needed.

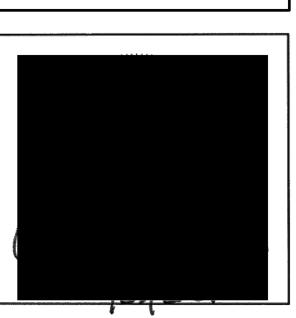
apply 4,000 lb/acre straw. anchor straw by tacking with asphalt, netting, or a mulch anchoring tool. A disk with blades set nearly straight can be used as a mulch anchoring tool.



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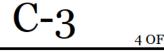
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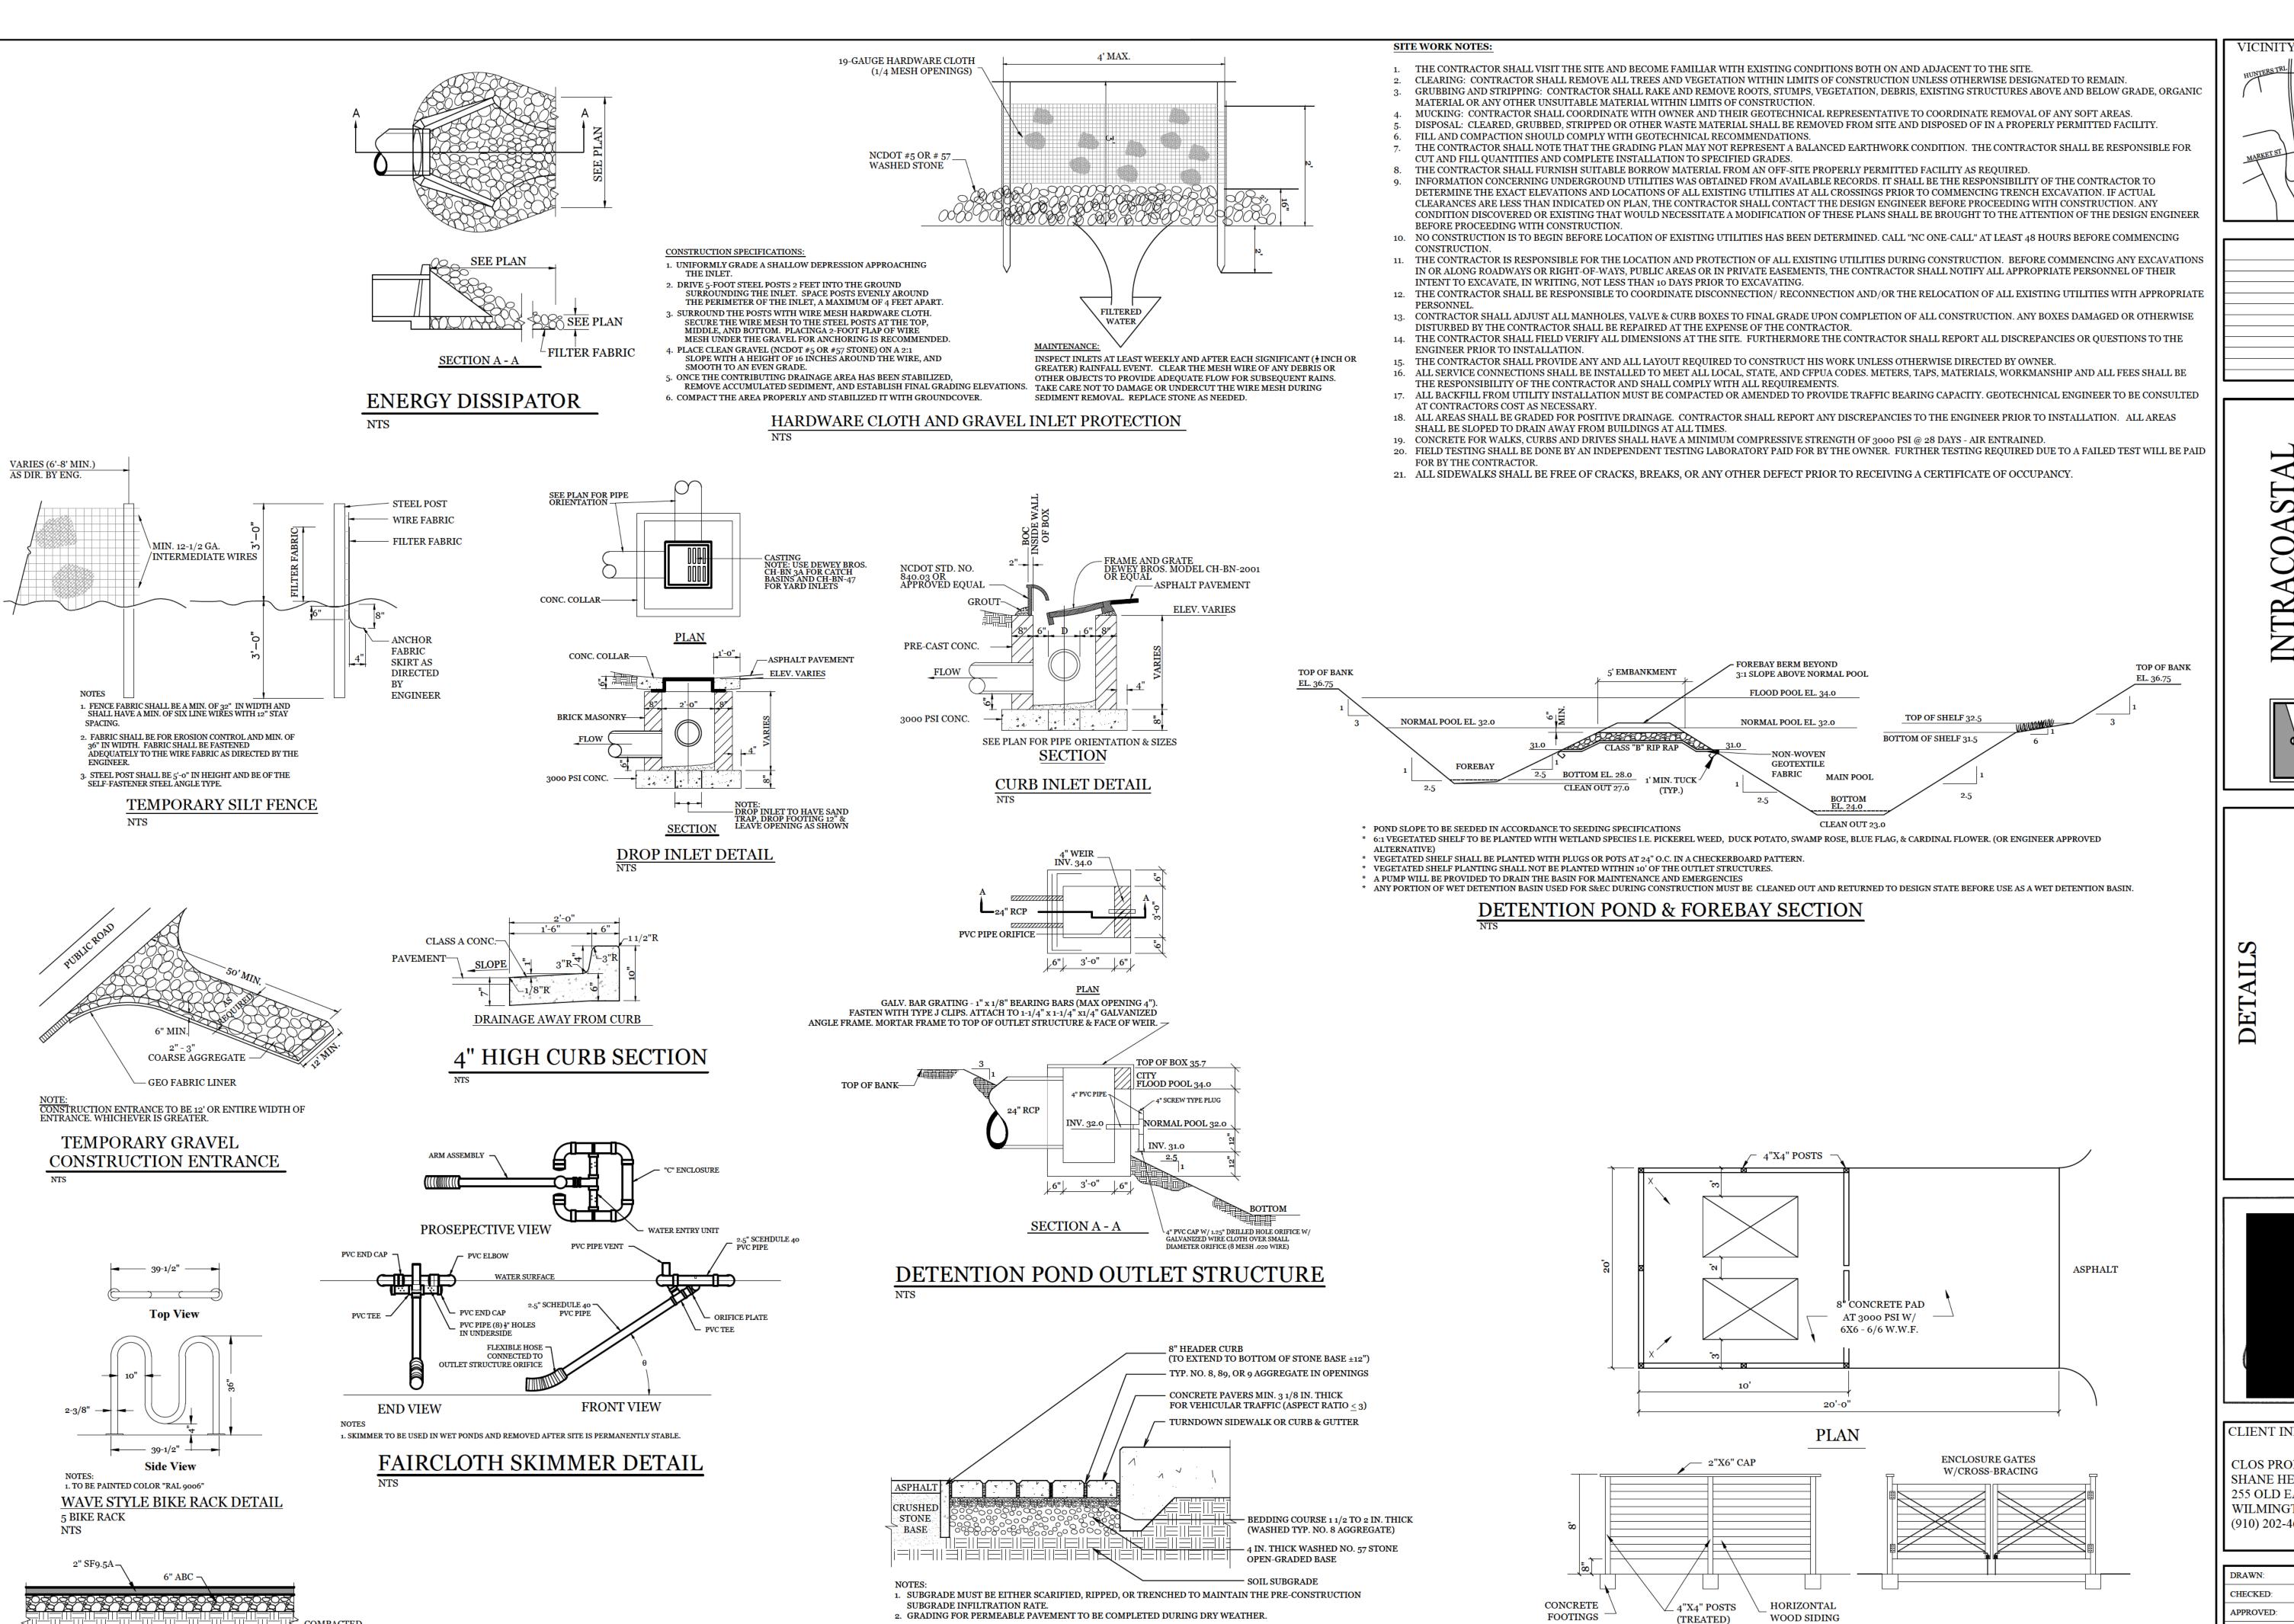


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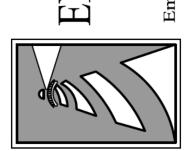




PERMEABLE PAVER SECTION

PARKING ASPHALT SECTION

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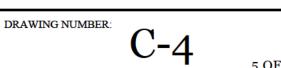
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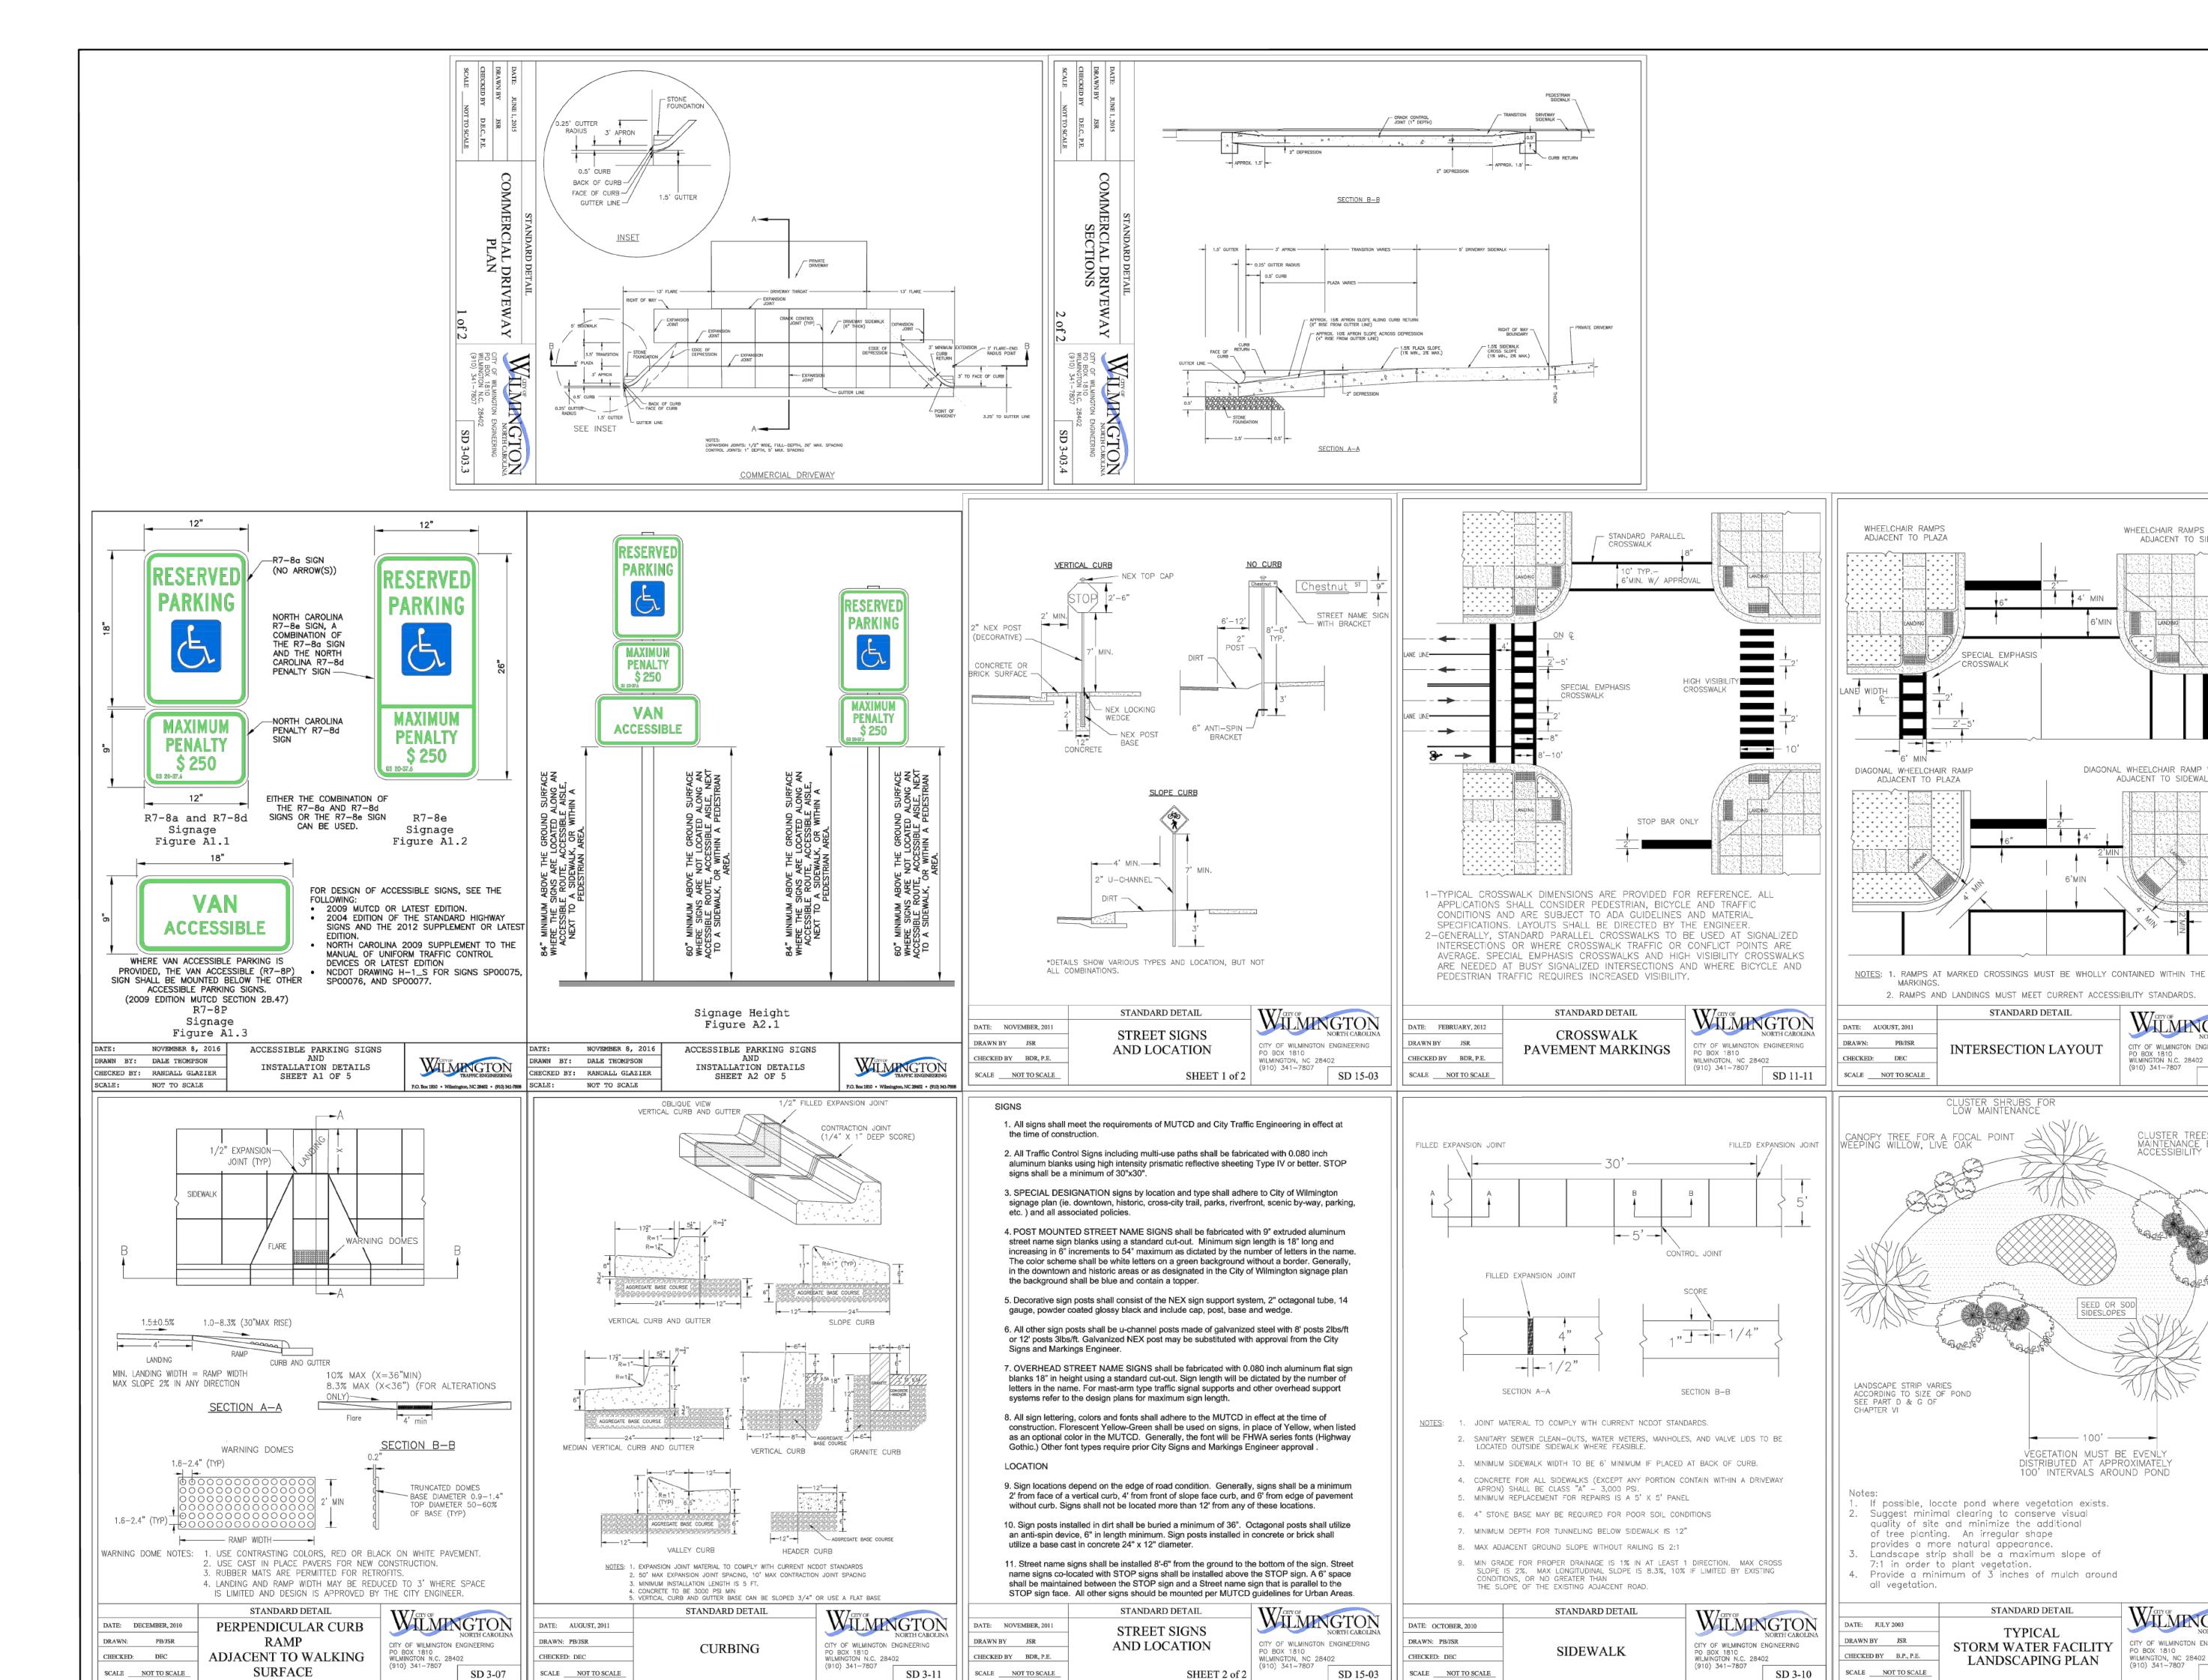
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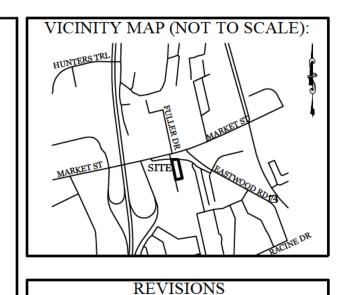
**ELEVATIONS** 

**DUMPSTER PAD & ENCLOSURE DETAIL** 

JAE SHEET SIZE: CDC DATE: 9/23/2021 CDC SCALE: NTS PROJECT NUMBER: 2021-024







PL INTRACOAS INGINEERINC

WHEELCHAIR RAMPS WITH FLARE

ADJACENT TO SIDEWALK

DIAGONAL WHEELCHAIR RAMP WITH FLARE

CITY OF WILMINGTON ENGINEERING PO BOX 1810 WILMINGTON N.C. 28402 (910) 341-7807

CLUSTER TREES TO ALLO MAINTENANCE EQUIPMENT ACCESSIBILITY

CITY OF WILMINGTON ENGINEERING

SD 15-16

PO BOX 1810 WILMINGTON, NC 28402

(910) 341-7807

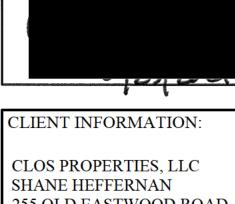
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ADJACENT TO SIDEWALK



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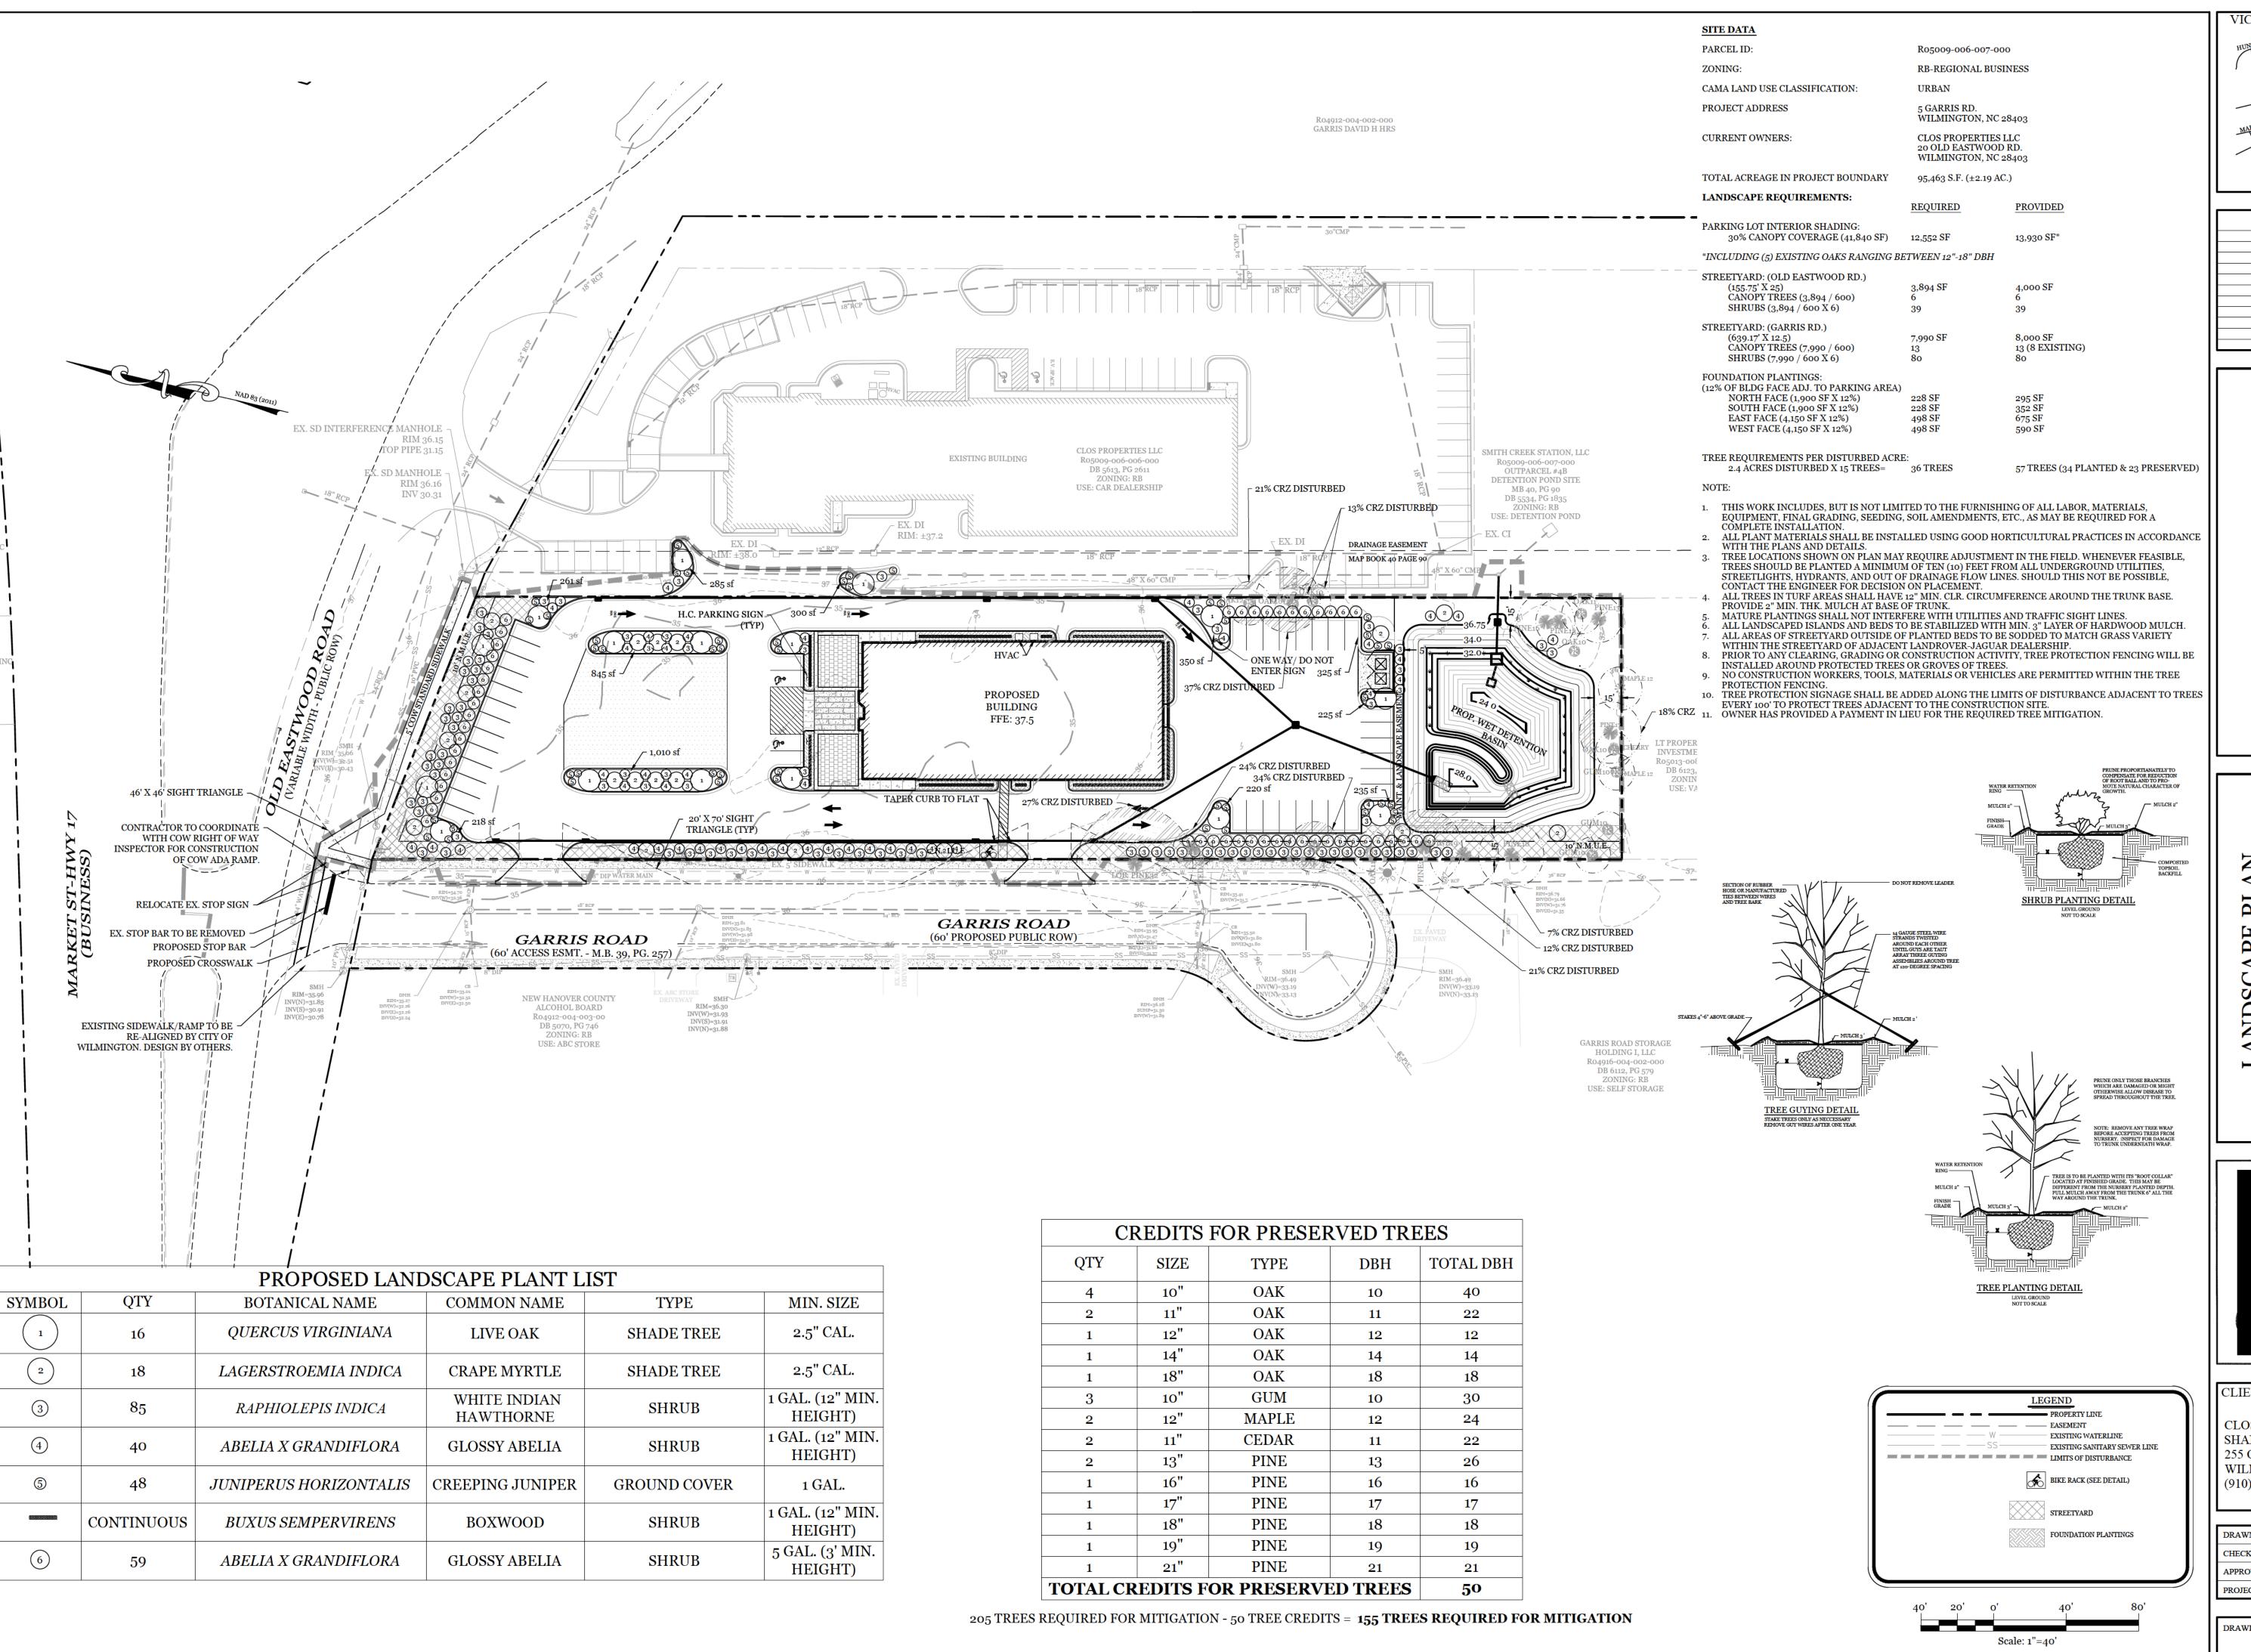
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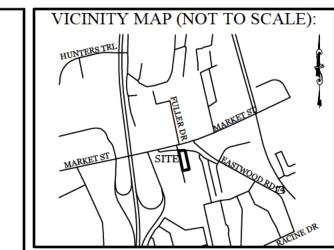


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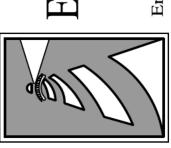
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DRAWING NUMBER L-1